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REVISIONS

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STAMP

PRELIMINARY  
 NOT FOR  
 CONSTRUCTION

ISSUING TITLE

SECOND FLOOR  
 WASTE & VENT PLAN

PROJECT TITLE

VAMC  
 RENOVATE  
 BUILDING 33

BUILDING NUMBER

33

CHECKED

RME

DRAWN

NUJ

APPROVED: SERVICE DIRECTOR

LOCATION

BOISE, IDAHO

DATE

03/04/11


PROJECT NO.

531-10-114

DWG NO.

P2.3

DWG 22 OF 102

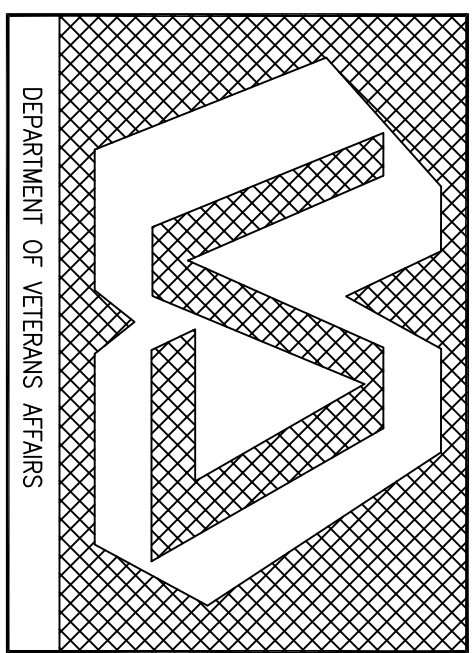


DEPARTMENT OF VETERANS AFFAIRS

7/6

1SECOND FLOOR WASTE & VENT PLAN

0' 4' 8' 12' 16' 20' 24'

SCALE: 1/4" = 1'-0"

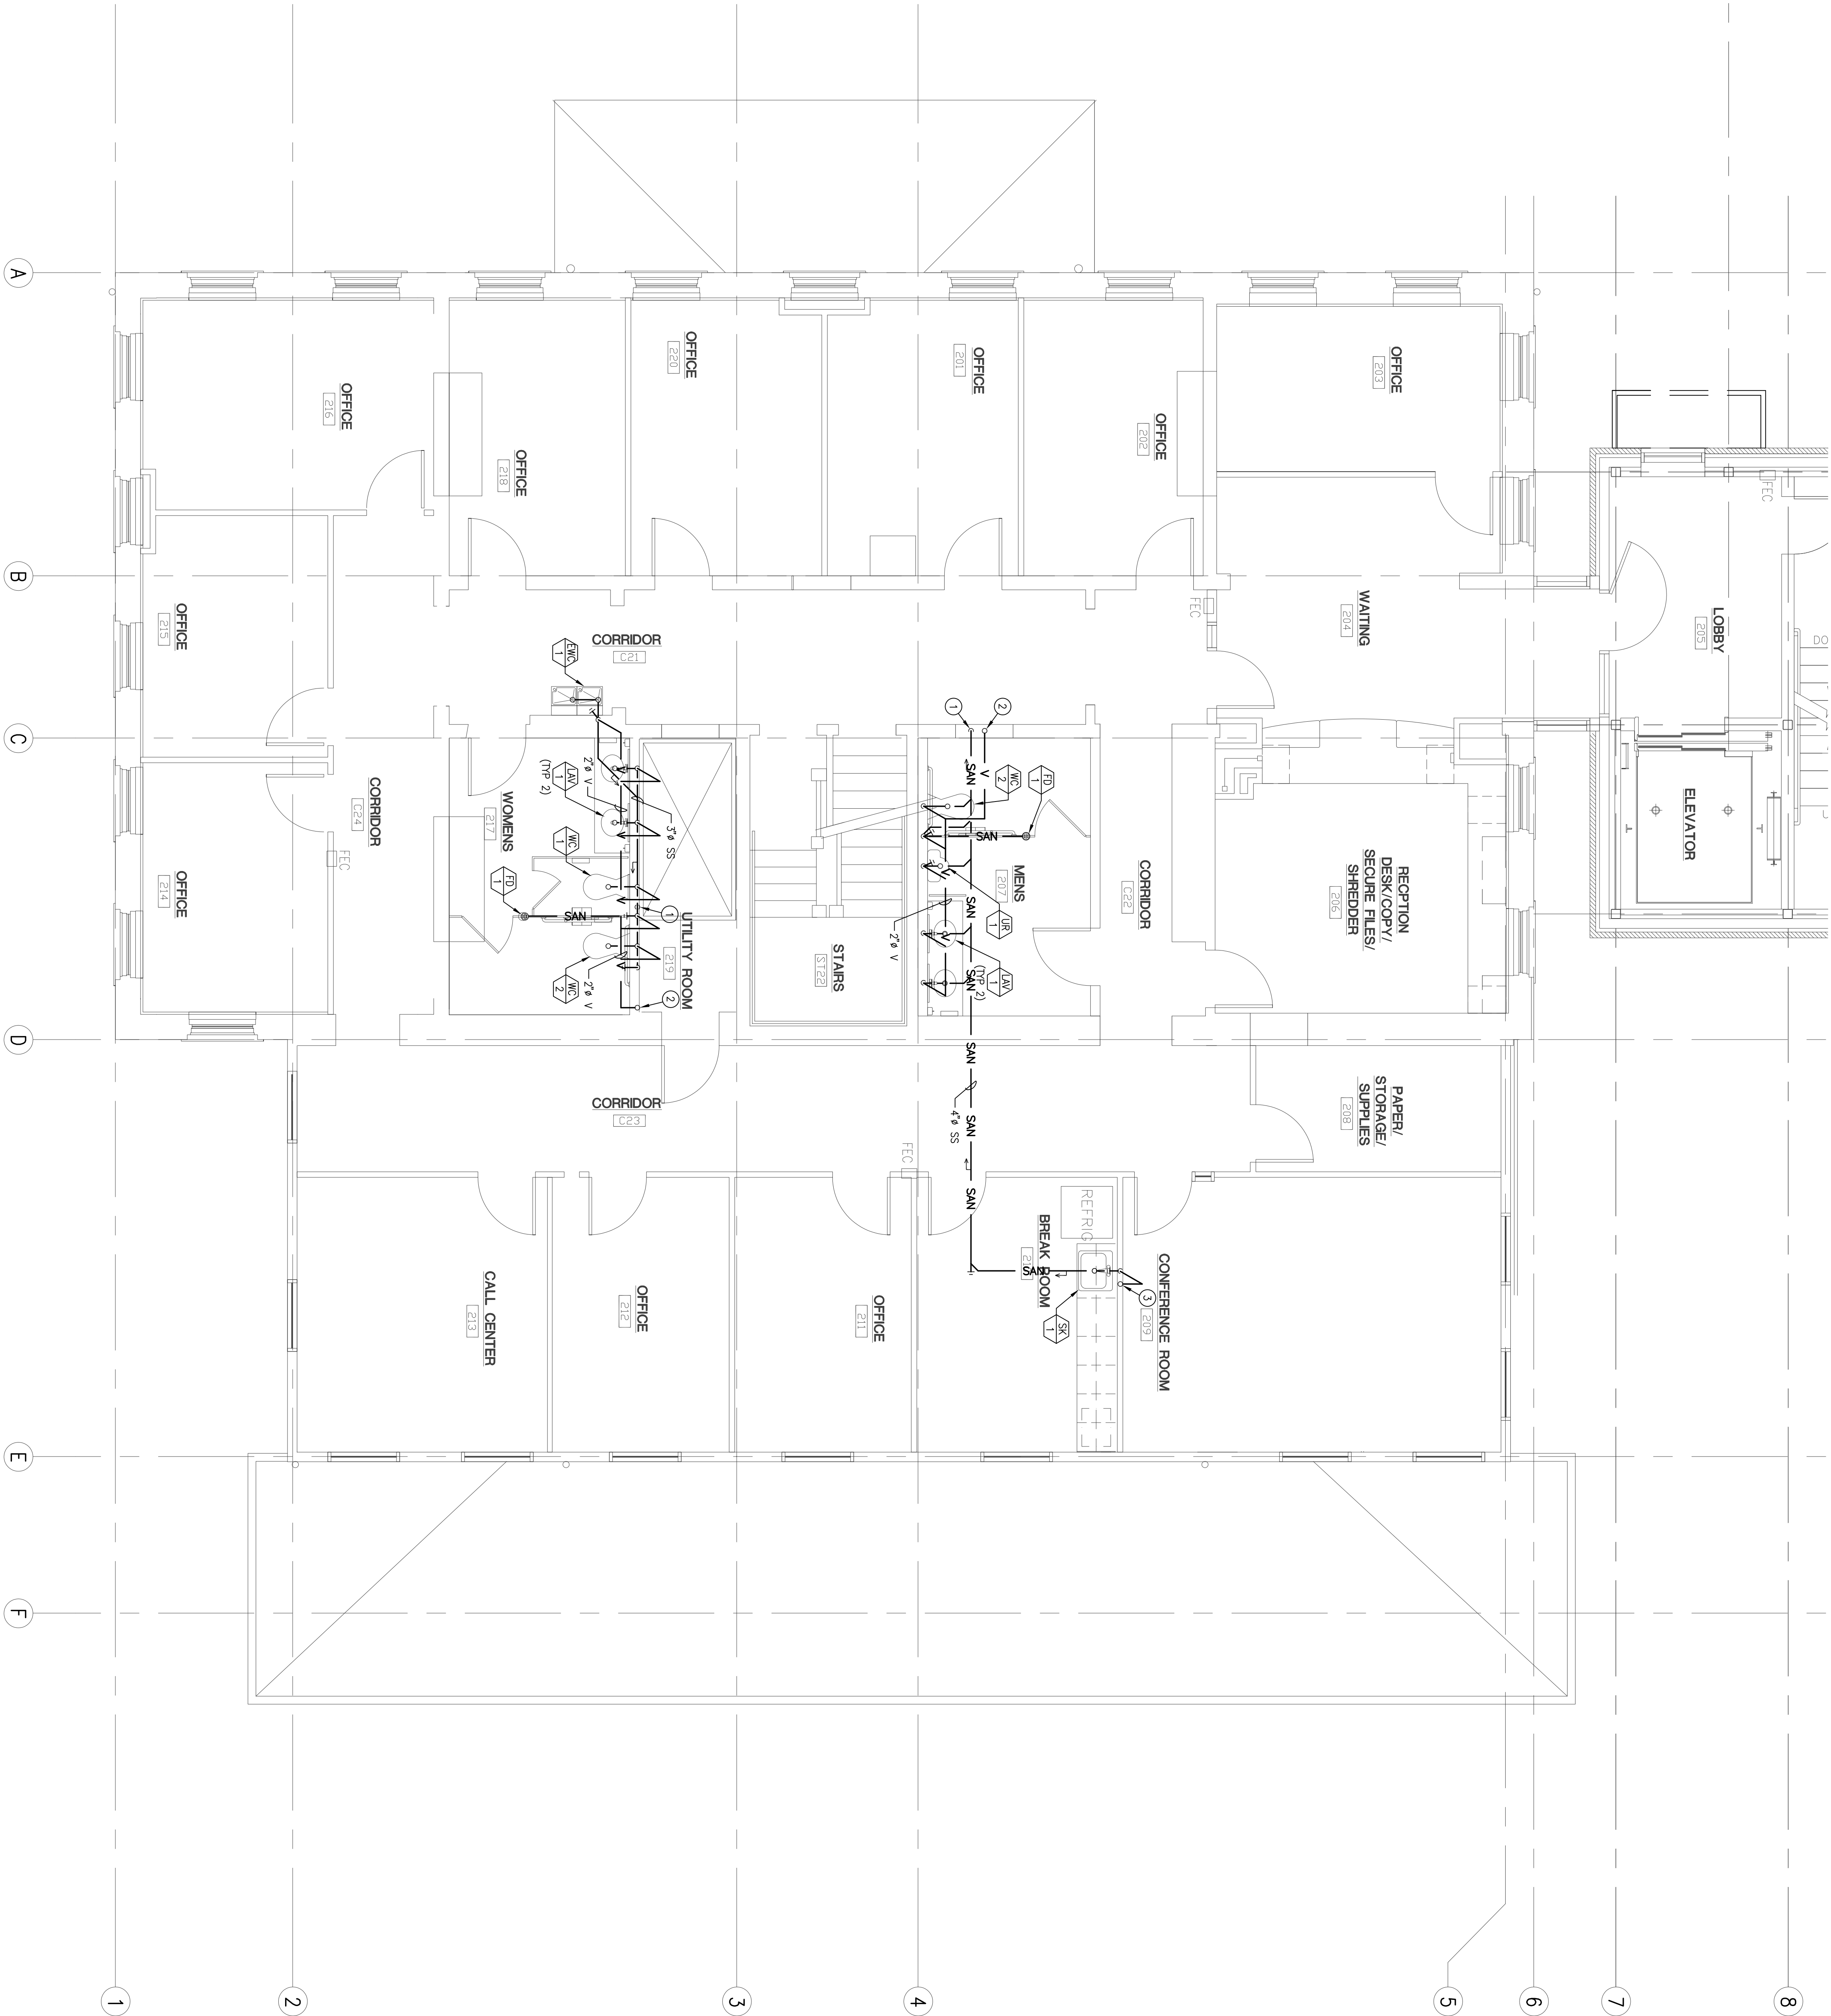

GENERAL NOTES:

- A. SLOPE ALL SS, DRY AND CONDENSATE PIPING AT 20.8 mm (1/4" PER FOOT) PER METER UNLESS NOTED OTHERWISE.
- B. ALL CONDENSATE PIPING IS 25.4 mm (1") UNLESS NOTED OTHERWISE.
- C. LOCATIONS OF POINTS OF CONNECTION TO WATER AND WASTE ARE APPROXIMATE. VERIFY ACTUAL LOCATIONS OF ALL POINTS OF CONNECTION IN FIELD.
- D. REFER TO THE MECHANICAL PLANS FOR EQUIPMENT AND DUCTWORK LOCATIONS BEFORE INSTALLING ANY PIPING. COORDINATE WITH THE MECHANICAL CONTRACTOR.
- E. PIPING PENETRATIONS THROUGH RATED ASSEMBLIES SHALL BE PRESTRESSED IN ACCORDANCE WITH 2008 IBC SECTION 712.
- F. CAREFULLY COORDINATE THE INSTALLATION OF ALL WASTE AND VENT PIPING LOCATED INSIDE WALLS OR ABOVE CEILINGS WITH OTHER TRADES PRIOR TO AND DURING CONSTRUCTION. COORDINATE PIPING ENTRY AND EXIT LOCATIONS WITH THE STRUCTURAL AND ARCHITECTURAL DRAWINGS PRIOR TO CONSTRUCTION.
- G. ALL PIPES THAT REQUIRE ACCESS, SUCH AS FOR OPERATING, CLEANING, STOPPING, PERSONS STANDING AT FLOOR LEVEL, OR STANDING ON PERMANENT PLATFORMS, WITHOUT THE USE OF PORTABLE LADDERS. EXAMPLES OF THESE TRADES INCLUDE, BUT ARE NOT LIMITED TO, MECHANICAL, ELECTRICAL, PLUMBING, AND HVAC. VERIFY ALL CONTROL DEVICES PRIOR TO COMMENCING INSTALLATION WORK. RESOLVE ANY CONFLICTS BETWEEN THIS REQUIREMENTS AND CONTRACT DRAWINGS TO THE RE/CORR FOR RESOLUTION.
- H. REFER TO DRAWING P3.1 FOR ALL PLUMBING DETAILS THAT ARE NOT REFERENCED.
- I. USE THE FOLLOWING CONVERSION TABLE TO CONVERT ALL PIPE SIZES FROM ENGLISH UNITS INTO METRIC UNITS.
- | ENGLISH UNITS | METRIC UNITS |
|---------------|--------------|
| 1 IN          | 25.4 mm      |
| 1-1/4 IN      | 31.8 mm      |
| 2 IN          | 50.8 mm      |
| 2-1/2 IN      | 63.5 mm      |
| 3 IN          | 76.2 mm      |
| 4 IN          | 101.6 mm     |
| 5 IN          | 127.0 mm     |
| 6 IN          | 152.4 mm     |
1. 4" SS DOWN TO FIRST FLOOR. RE: P2.2-1 FOR CONTINUATION.
2. 2" V UP FROM FIRST FLOOR TO THIRD FLOOR. RE: P2.2-1 AND P2.4-1 FOR CONTINUATION.
3. 2" V UP TO THIRD FLOOR. RE: P2.4-1 FOR CONTINUATION.

SHEET NOTES: